

TOWN OF CHESHIRE DEPARTMENT OF PUBLIC WORKS/ENGINEERING 84 SOUTH MAIN STREET, CHESHIRE, CONNECTICUT 06410 Telephone (203) 271-6650 Fax (203) 271-6659

WEST MAIN STREET STREETSCAPE IMPROVEMENTS PHASE 3, WILLOW STREET CORRIDOR

RFP #2223-29

ADDENDUM NO. 1

June 16, 2023

NOTICE TO ALL BIDDERS:

The attention of all bidders submitting proposals for this RFP is called to the following Addenda to the specifications and plans. The items set forth herein, whether of omission, addition or substitution are to be included in, and form part of the specifications and plans of the above-named project for bids to be received as advertised.


The following clarifications, modifications, deletions and additions are hereby incorporated into and become part of the Contract Documents.


RESPONSES TO QUESTIONS RECEIVED:


- **Question 1:** Can I submit a bid solely for the fencing aspect of the project?
- Response 1: No. the scope of work consists of furnishing sidewalks on the west side of Willow Street. Work includes demolition, erosion control, earth excavation, site grading, installation of sidewalks, installation of site furniture & fencing, installation of site lighting, and loaming & seeding of disturbed areas.
- **Question 2:** For the Site lighting is the site contractor responsible for conduit and wire? There is no detail showing where the electrical is coming from.
- Response 2: See attached Sk-C1 and drawings EL-1 thru EL-3 from the West Main Street Streetscape Project c. 2010. Power shall be obtained from the existing splice box at West Main Street and Willow Street. Contractor shall confirm sufficient power is available from this location and shall provide an Electrical Plan for the new lights along Willow Street as outlined in Specification Section 26-00-00. The Electrical Plan shall be signed by a Professional Engineer licensed in the State of Connecticut and shall be reviewed and approved by Town of Cheshire Building Department prior to installation.

ATTACHMENTS:

- 1. Sketch SK-C1 "Site Lighting Power Source" dated June 15, 2023 prepared by Cabezas DeAngelis Engineers & Surveyors. (1 Sheet)
- 2. Electrical Plan for West Main Street Streetscape Improvements Phase II dated March 11, 2010 prepared by Silver/Petrucelli & Associates. (3 Sheets)

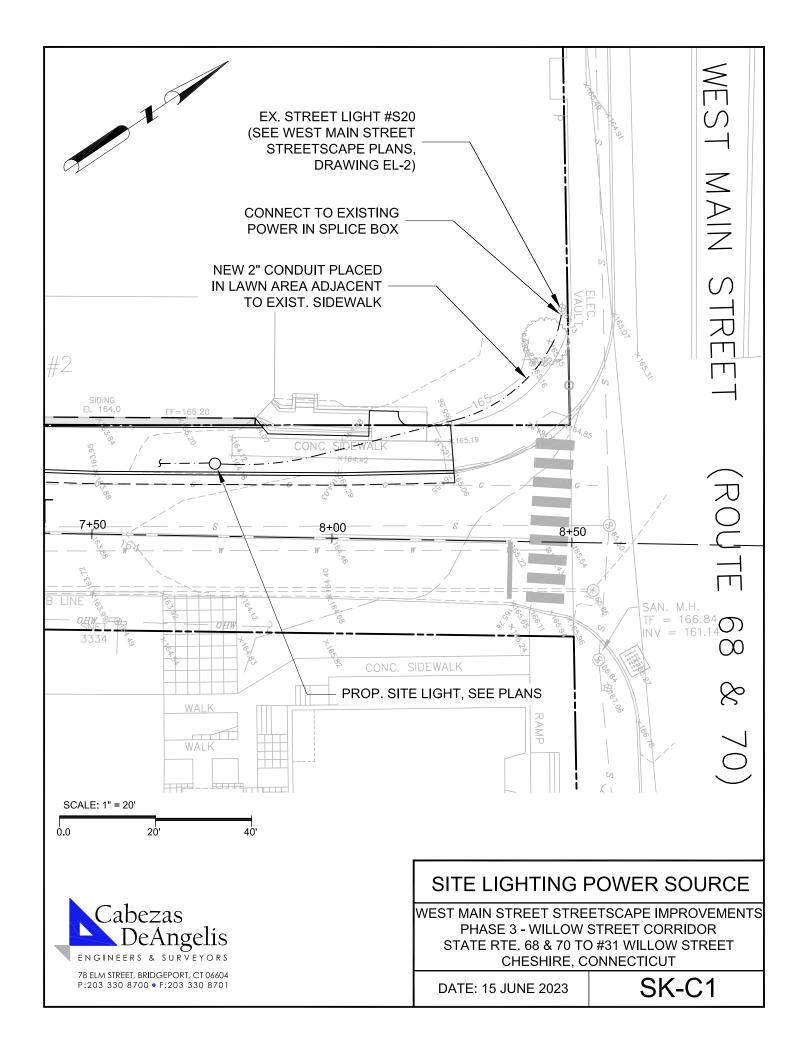

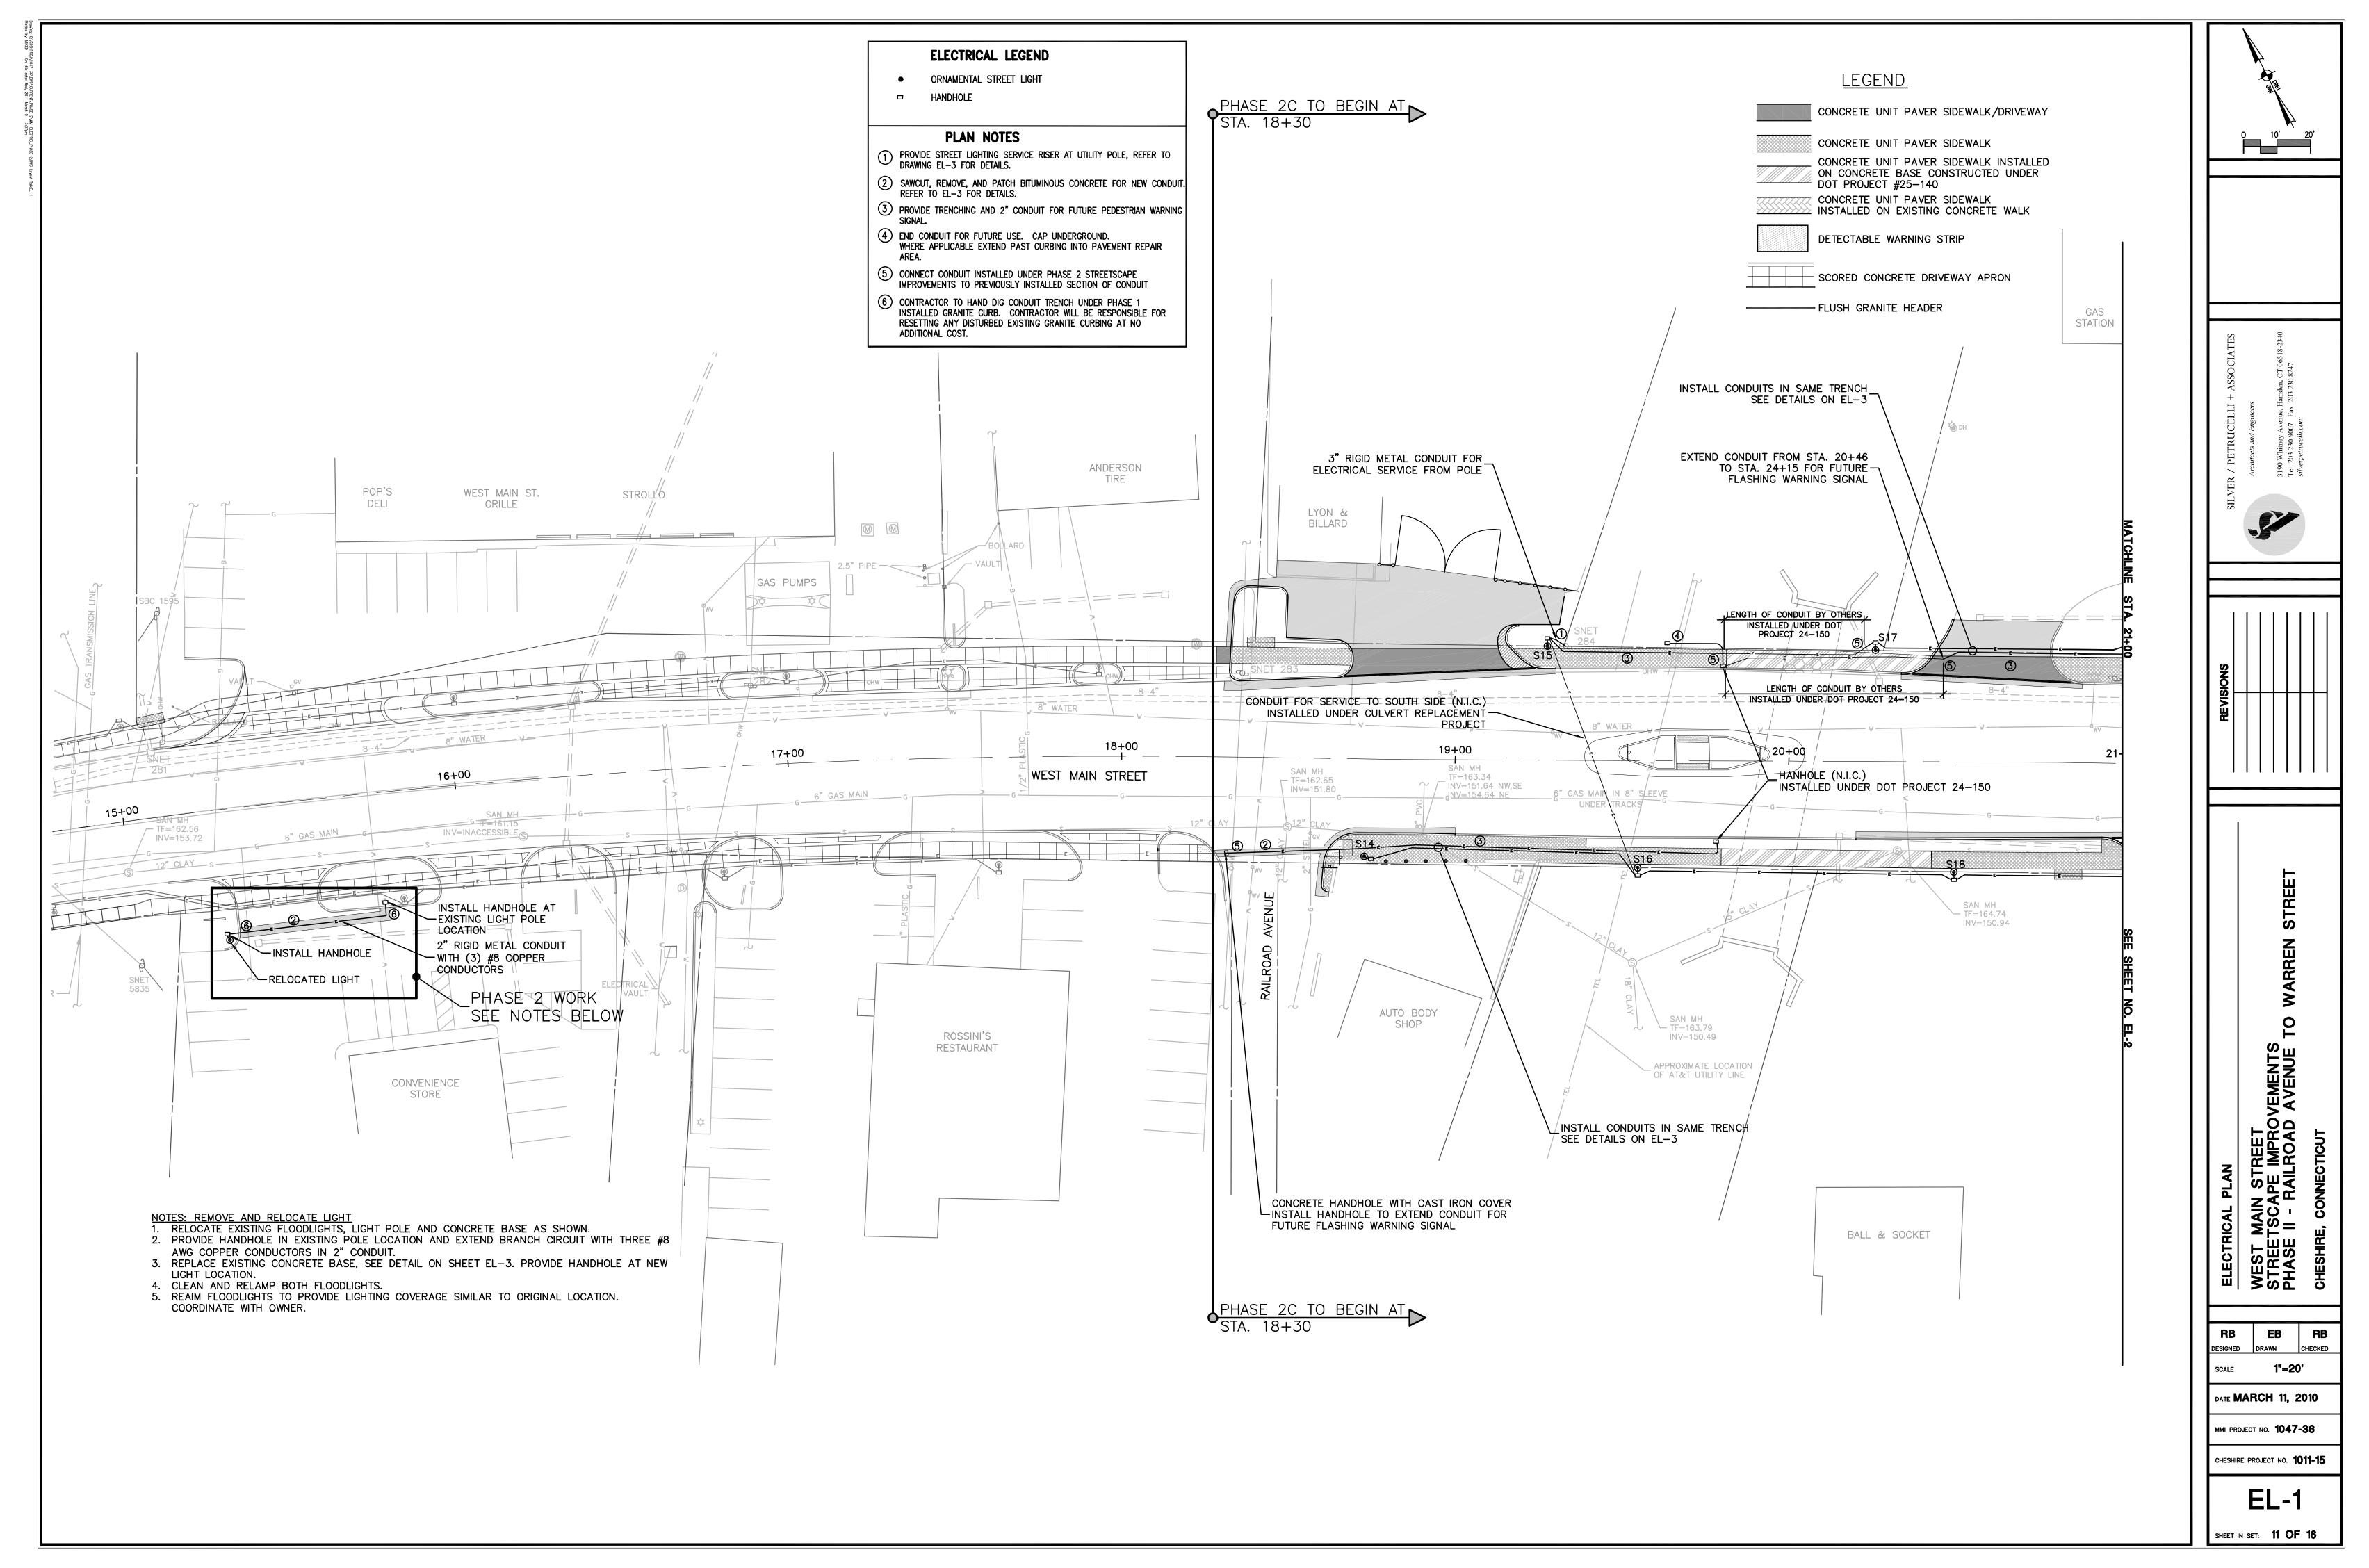

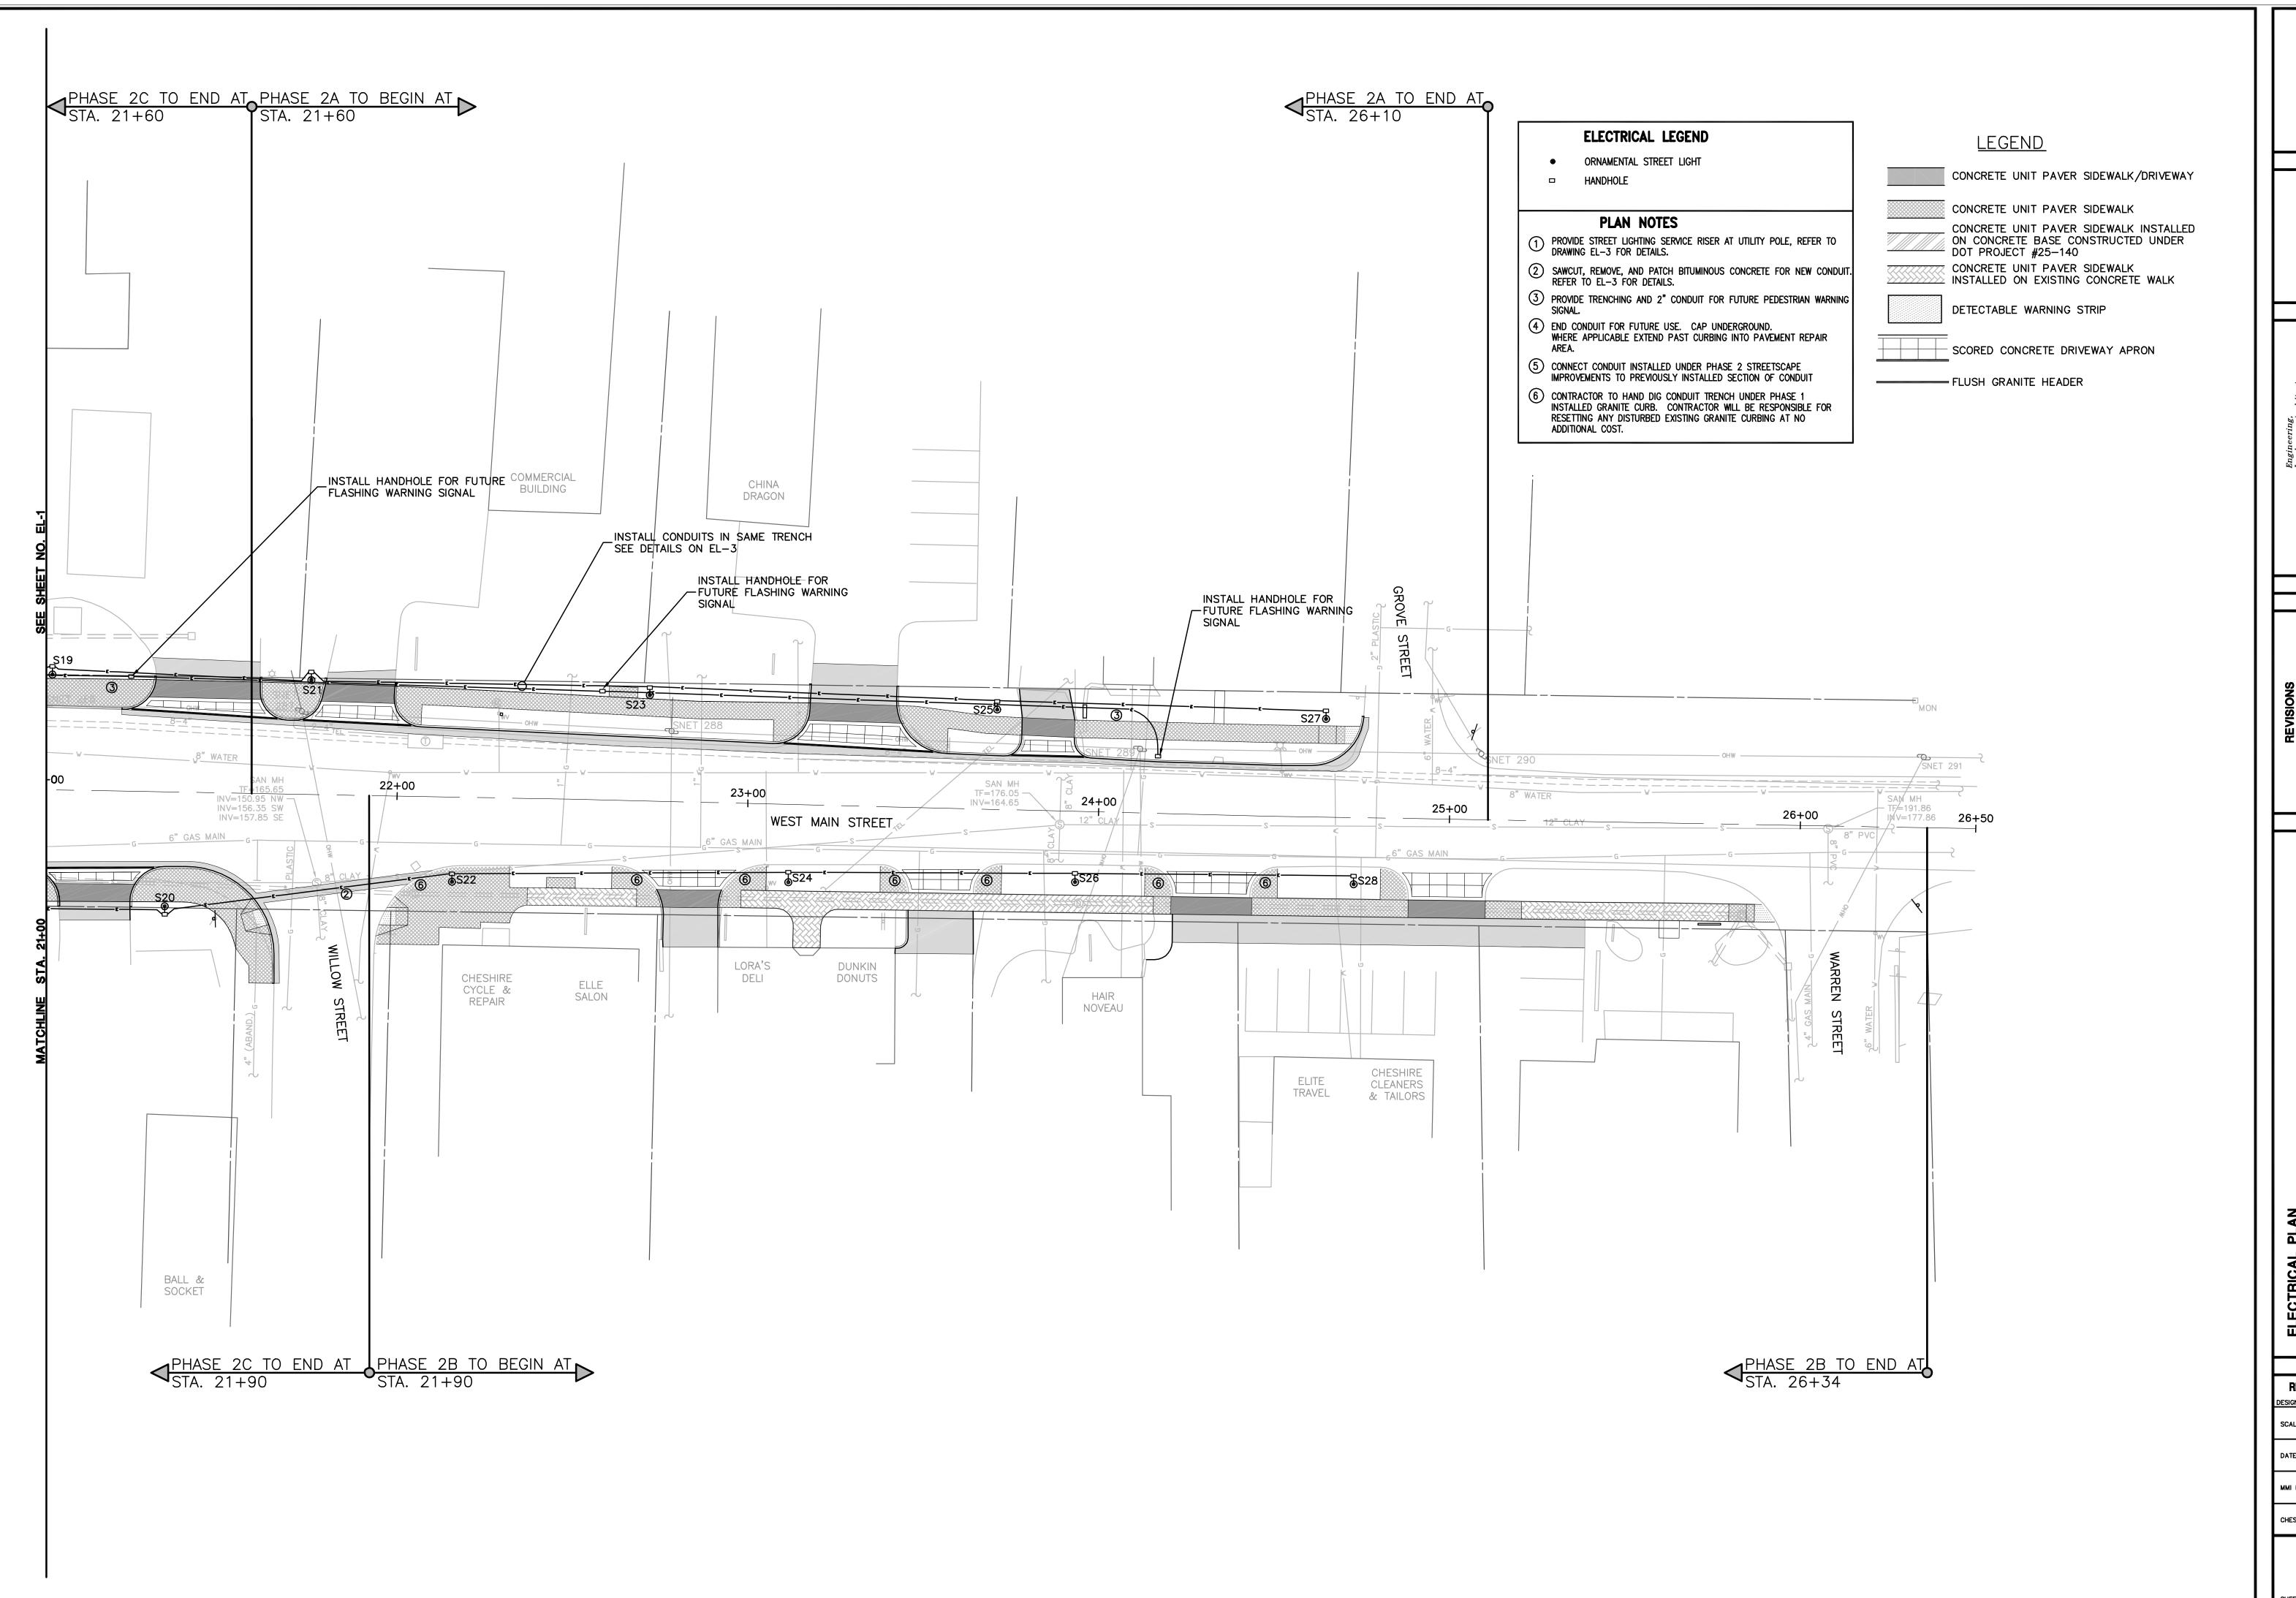

0 10' 20'

Landscape Architecture and Environmental Science

NE & MACBROOM.

Prive
Connecticut 06410
773 Fax (203) 272-9733

reandmacbroom.com

REVISIONS

WEST MAIN STREET
STREETSCAPE IMPROVEMENTS
PHASE II - RAILROAD AVENUE TO WARREN
CHESHIRE, CONNECTICUT

RB EB RB
GNED DRAWN CHECKED


ALE 1"=20'


DATE MARCH 11, 2010


ммі ргојест но. 1047-36

CHESHIRE PROJECT NO. 1011-15

EL-2SHEET IN SET: 12 OF 16

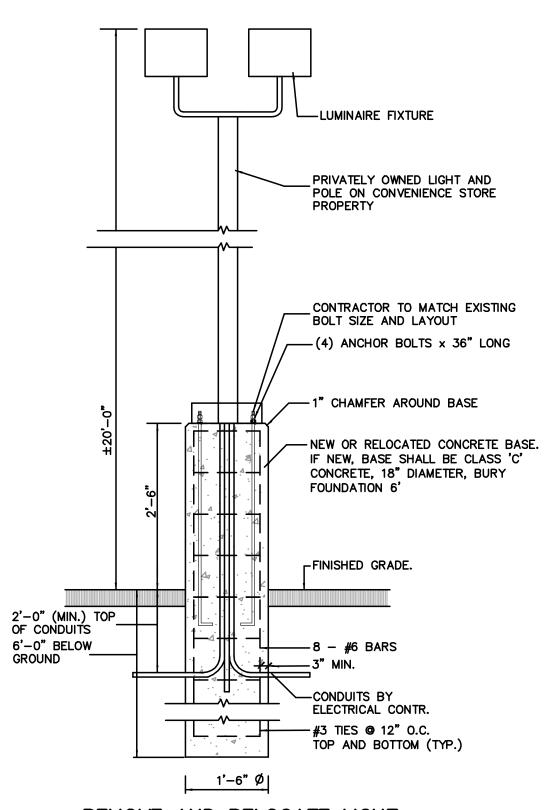


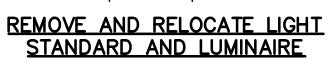

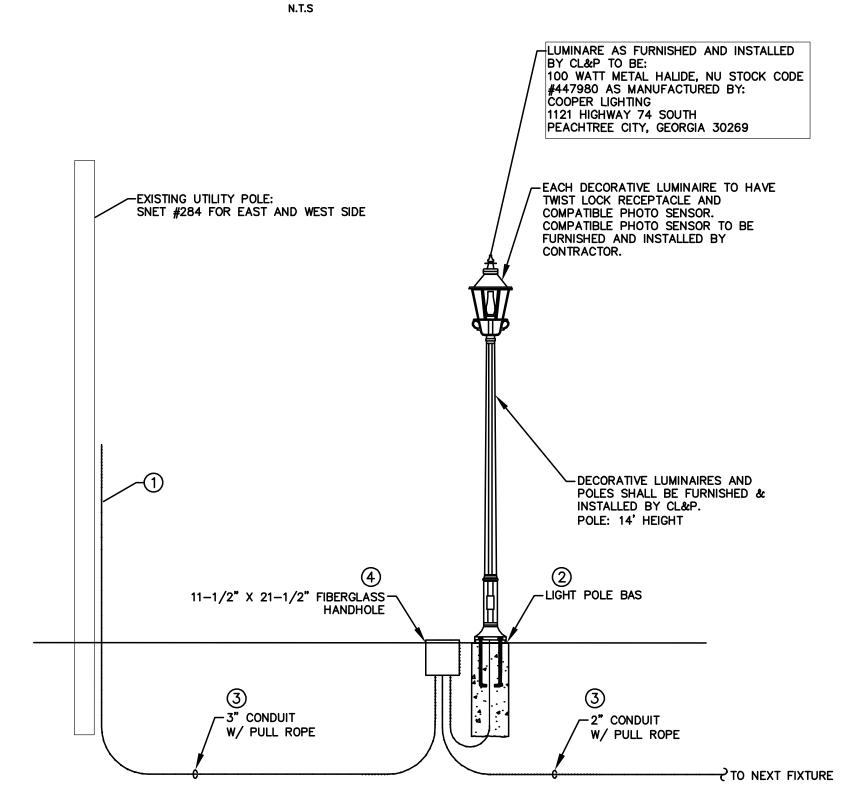


ELECTRICAL 1—LINE DIAGRAM SCALE: N.T.S.

- PROVIDE STREET LIGHTING SERVICE RISER AT UTILITY POLE. INSTALL RIGID SWEEP, 10' RIGID RISER & FIRST STAND-OFF. FURNISH ADDITIONAL RIGID CONDUIT, STANDOFFS, GROUNDING CLAMP & WEATHERHEAD FOR INSTALLATION BY CL&P.
- 2 CL&P SHALL FURNISH PRECAST CONCRETE LIGHT POLE BASES FOR INSTALLATION BY CONTRACTOR.
- CONTRACTOR SHALL FURNISH AND TRENCH ALL CONDUITS TO AND FROM LIGHT FIXTURE LOCATIONS. CL&P SHALL FURNISH AND INSTALL ALL WIRING TO LIGHT FIXTURES. CL&P SHALL INSTALL AND CONNECT ALL LIGHT POLES.
- (4) CONTRACTOR SHALL PROVIDE HANDHOLE AT EACH LIGHT POLE.

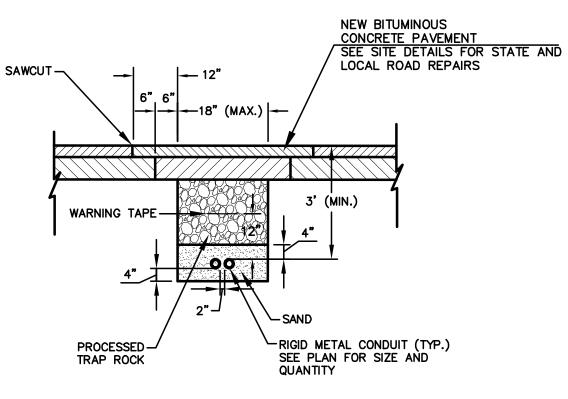


TYPE I TRENCHING AND BACKFILLING RIGID METAL CONDUIT IN BITUMINOUS PAVEMENT

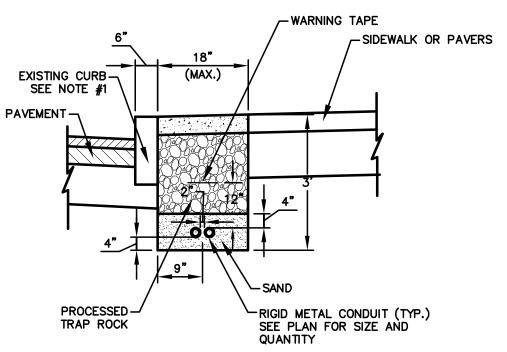


NOTE #1- IF EXCAVATION IS ADJACENT TO EXISTING CURB, ADDITIONAL PRECAUTIONS ARE TO BE TAKEN TO AVOID DISPLACEMENT OF CURBING AT NO ADDITIONAL COST

TYPE III TRENCHING AND BACKFILLING RIGID METAL CONDUIT IN CONCRETE SIDEWALK

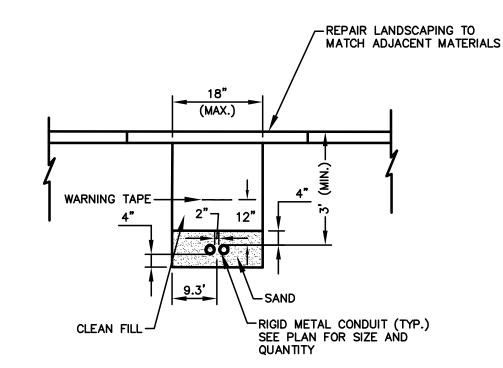



TRENCHING AND BACKFILL RIGID METAL CONDUIT IN LANDSCAPING SCALE: N.T.S.

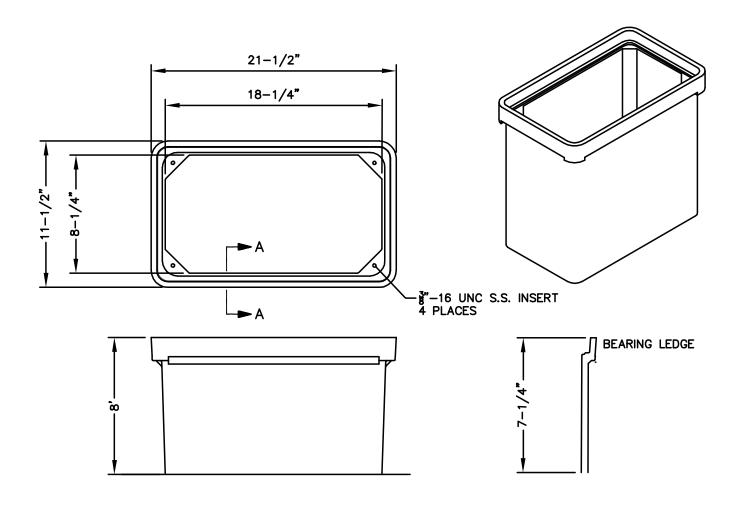


FIBERGLASS HANDHOLE SCALE: N.T.S.

- 1. HANDHOLES SHALL BE SET ON A 12" BED OF COMPACTED CRUSHED STONE OR PROCESSED GRAVEL. BED SHALL EXTEND 6" BEYOND EACH WALL (i.e. 13"x24" BOX, PAD SHALL BE 25"x36"). THE EXTERIOR OF THE BOTTOM BOX SHALL BE BACKFILLED WITH 12" OF COMPACTED BED MATERIAL.
- 2. HANDHOLES SHALL BE OPEN BOTTOM TYPE, WITH APPROXIMATE NOMINAL DIMENSIONS AS SHOWN WITH A 1 1/4" BOTTOM EDGE. TOP SHALL BE DESIGNED WITH BOLT HOLES, PULL SLOT AND CUSTOM LOGO. BOX COLOR SHALL BE SELECTED FROM MANUFACTURER'S STANDARD COLORS. HANDHOLES SHALL BE UL LISTED TIER 10 (MINIMUM). HANDHOLE COVERS SHALL BE SECURED WITH STAINLESS STEEL PENTA-HEAD BOLTS.
- 3. PROVIDE PRODUCT DATA SHEETS, WHICH INDICATE DIMENSIONS, DESIGN INFORMATION, LOAD RATING DATA, MATERIAL INFORMATION, ALONG WITH MANUFACTURER'S INFORMATION FOR REVIEW. SUBMIT PRODUCT SAMPLES, IN MANUFACTURER'S STANDARD COLORS TO ALLOW FOR COLOR SELECTION. PRODUCT SAMPLES SHALL HAVE NOMINAL DIMENSIONS OF 4"x6".
- 4. WHERE REQUIRED, CONTRACTOR SHALL FIELD DRILL HANDHOLES TO INSTALL CONDUITS FOR LIGHT POLES. AFTER INSTALLATION OF CONDUIT, HOLES SHALL BE SEALED, USING MATERIALS AS RECOMMENDED BY THE HANDHOLE MANUFACTURER.
- 5. LOGO FOR TOP SHALL BE "ELECTRIC" OR "LIGHTING" AS APPROPRIATE IN 2" HIGH LETTERS. PROVIDE A FULL SIZE SAMPLE FOR REVIEW.
- 6. HANDHOLES IN ROADWAY SHALL BE CONCRETE HANDHOLE TYPE II WITH CAST IRON COVER AS DETAILED ON CTDOT STANDARD SHEET TR-1010_01. HANDHOLES IN GRASS AREAS MAY BE AS NOTED ABOVE OR STANDARD HIGH DENSITY POLYETHYLENE BODY AND COVER EQUAL TO NU STOCK CODE ITEM 0440481.

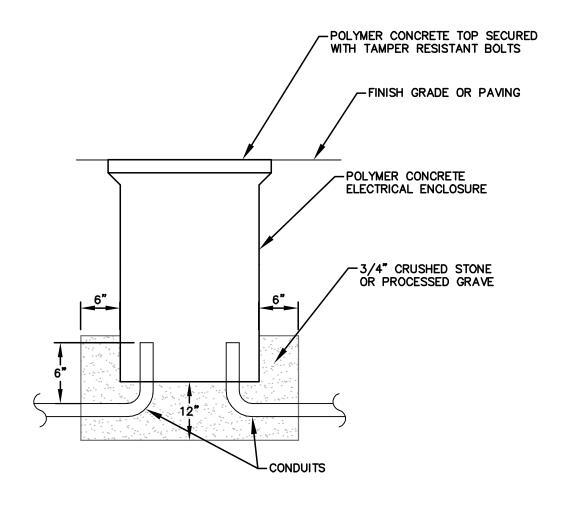


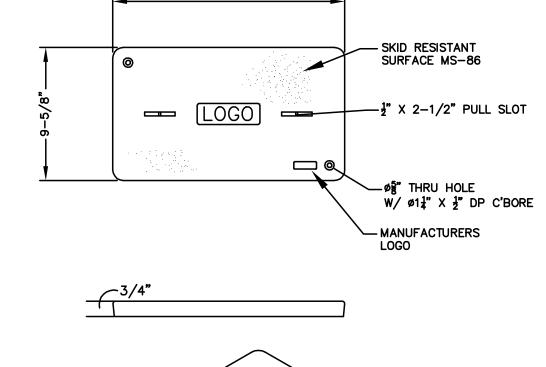

19-5/8"

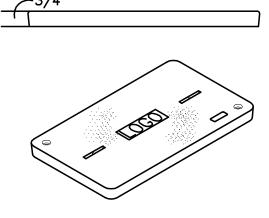


HANDHOLE BOX COVER DETAIL SCALE: N.T.S.

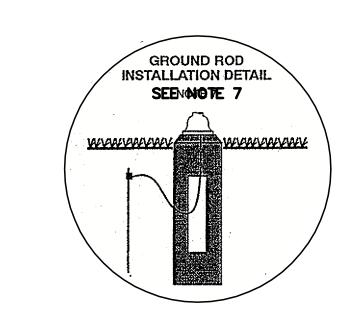

INSTALLED BY CL&P

<u>LIGHTING NOTES:</u>

- 1. CL&P WILL FURNISH AND INSTALL DECORATIVE LIGHT POLES & LUMINAIRE. 2. CL&P WILL PROVIDE CONCRETE LIGHT POLE BASES FOR CONTRACTOR TO INSTALL.
- 3. THE CONTRACTOR SHALL INSTALL CL&P FURNISHED CONCRETE BASES AND COORDINATE AVAILABILITY OF BASES WITH CL&P.
- 4. THE CONTRACTOR SHALL FURNISH AND INSTALL CONDUIT FOR LIGHTING. 5. CONTRACTOR SHALL FURNISH AND INSTALL PHOTO SENSORS COMPATIBLE WITH
- THE TWIST LOCK RECEPTACLE FOR ALL LUMINAIRES. 6. CL&P WILL FURNISH AND PULL WIRE FOR LIGHTING.
- 7. INSTALL GROUND ROD AT TIME OF BASE INSTALLATION. GROUND ROD AND CONNECTOR SHALL BE BELOW GRADE WITH #6 COPPER GROUND WIRE RUN UP THROUGH THE CENTER OF THE BASE.
- 8. CONTRACTOR TO INSTALL ALL CONCRETE LIGHT POLE FOUNDATIONS; PLUMB AND LEVEL AS FURNISHED BY CL&P; CONTRACTOR TO FURNISH AND INSTALL GROUND RODS AND CONDUIT PER PLAN AND DETAILS. CL&P TO FURNISH AND INSTALL
- 9. CONTRACTOR SHALL VERIFY LOCATIONS OF EXISTING, UTILITIES PRIOR TO INSTALLING LIGHT BASES. ANY CONFLICTS SHALL BE BROUGHT TO THE ATTENTION OF THE ENGINEER IMMEDIATELY FOR RESOLUTION.

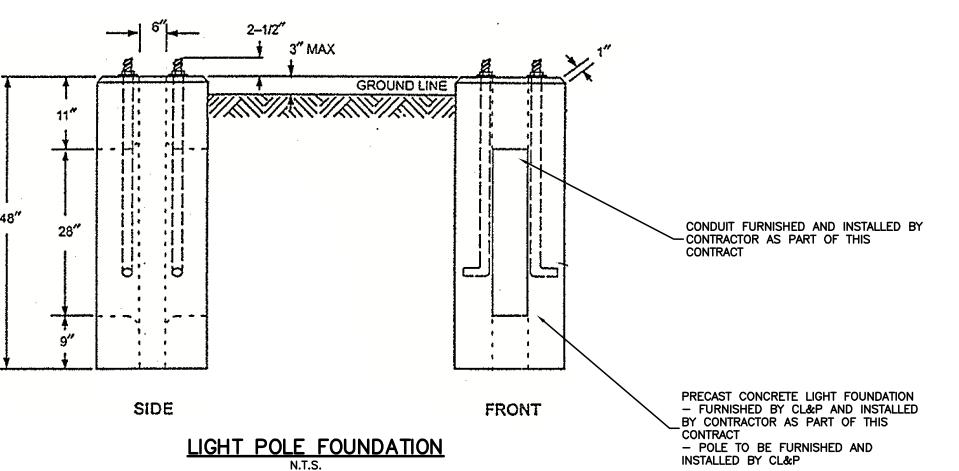

LIGHT POLES AND PULL WIRE FOR CONNECTIONS.

IMPROVEMENT LROAD AVENU

EB

ATE MARCH 11, 2010

MMI PROJECT NO. 1047-36

SCALE AS SHOWN

CHESHIRE PROJECT NO. 1011-15

SHEET IN SET: 13 OF 16